# ODYSSEY PRESCHOOL

C.U.P. APPLICATION

430 S. ABEL STREET MILPITAS, CA 95035

# BUILDING CODES:

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### ARCHITECTURAL / STRUCTURAL

2013 CALIFORNIA BUILDING CODE (CBC) AND AMENDMENTS

2010 CALIFORNIA ENERGY CODE AND EFFICIENCY STANDARDS

2013 CALIFORNIA CODE OF REGULATIONS (CCR)

2013 CALIFORNIA ADMINISTRATIVE CODE (CAC)

### PLUMBING / MECHANICAL

2013 CALIFORNIA PLUMBING CODE AND AMENDMENTS

2013 CALIFORNIA MECHANICAL CODE AND AMENDMENTS

### ELECTRICAL

2013 CALIFORNIA ELECTRICAL CODE AND AMENDMENTS

### FIRE PROTECTION

2013 CALIFORNIA FIRE CODE AND AMENDMENTS

NATIONAL FIRE PROTECTION ASSOCIATION STANDARDS (NFPA)

# PROJECT SUMMARY

ODYSSEY PRESCHOOL IS AN EXCITING LEARNING ENVIRONMENT THAT SPECIALIZES IN EARLY CHILDHOOD EDUCATION AND DEVELOPMENT. EACH PROGRAM IS DESIGNED TO HELP EACH CHILD DEVELOP ADVANCED SOCIAL, PHYSICAL, INTELLECTUAL, AND EMOTIONAL SKILLS TO SUCCEED BEYOND PRESCHOOL AND IN DAILY LIFE.

# SCOPE OF WORK

THIS PROJECT PROPOSES TO CONVERT AN EXISTING MULTI-TENANT MEDICAL OFFICE BUILDING INTO A SINGLE TENANT PRESCHOOL / CHILD DAY CARE FACILITY. THE EXISTING SINGLE STORY BUILDING WILL BE REDUCED APPROX. 700 S.F. IN ORDER TO IMPROVE SITE ACCESS, LANDSCAPE AREA AND PARKING. IN ADDITION TO THE EXTERIOR IMPROVEMENTS, ODYSSEY PRESCHOOL WILL CONSTRUCT ALL NEW INTERIOR SPACES, PROPER ADA ACCESS, AN OUTDOOR PLAY AREA AND A WIDER DRIVEWAY TO MEET CITY STANDARDS.

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P1.0 PLAY AREA / EQUIPMENT

# VICINITY MAP



# PROJECT DATA

APPLICANT'S NAME & PHONE NO .:	MR. SANJAY PRASANNA	(650) 678-1842
BLDG. OWNER'S NAME & PHONE NO .:	LELAND W. HANCOCK	(510) 719-5029
ARCHITECT & PHONE NO.:	KEVIN N. MATTOS	(408) 999-6622
PROJECT ADDRESS:	430 S. ABEL STREET, MILPITAS	, CA 95035
ASSESSOR'S PARCEL NUMBER:	APN: 086-10-006	
LOT SIZE:	0.41 NET ACRES / 18,000 S. F	FT.
	EXISTING:	PROPOSED
ZONING DISTRICT:	MXD - MIXED USE	(NO CHANGE)
OCCUPANCY USE:	BUSINESS / MEDICAL OFFICE	CHILD DAY CARE
OCCUPANCY GROUP:	8	I-4 / E
TYPE OF CONSTRUCTION:	V-B	V-B
FIRE SPRINKLERS:	YES	YES
FIRE ALARM SYSTEM:	NO	YES
BUSINESS DESCRIPTION:	SERVICE CHILDREN 6 MOS. TO WILL BE 7:30 AM TO 6:30 PM PICK UP PROGRAMS MONDAY T	OPERATING A CHILD DAY CARE 5 YRS. OF AGE. BUSINESS HOURS WITH STAGGERED DROP OFF AND OF FRIDAY. THE BUSINESS WILL SING AND MEET ALL NECESSARY POSED TENANT USE.
SITE/ BUILDING DESCRIPTION:	COMMERCIAL TENANT SPACE (A	D IN AN EXISTING SINGLE STORY APPROX. 5,300 S.Q. F.T.). PARKING VAILABLE ON THE PROPERTY — SEE SS.



STREET FRONT VIEW ON S. ABLE STREET



VIEW FROM REAR PARKING AREA



PEDESTRIAN VIEW ON S. ABLE STREET



VIEW OF EXISTING BUILDING AT REAR



EXISTING MONUMENT SIGN



VIEW OF PROPOSED ENTRY AREA

kevin n. mattos architect
111 w. st. john street. suite eso
son jose, ca. e e 110

kma

PRESCHOOL

SEY

S

430 S. ABEL STREET MILPITAS, CA 95035

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JOB NUMBER: 1418.00 DRAWN: 8. CHECKED: kr

DATE: ISSUED: 05.14.14 CUP Application 05.14.14 CUP Revisions


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SHEET NUMBER:

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p<sub>|</sub> 400.000.0404 kma architecture+design

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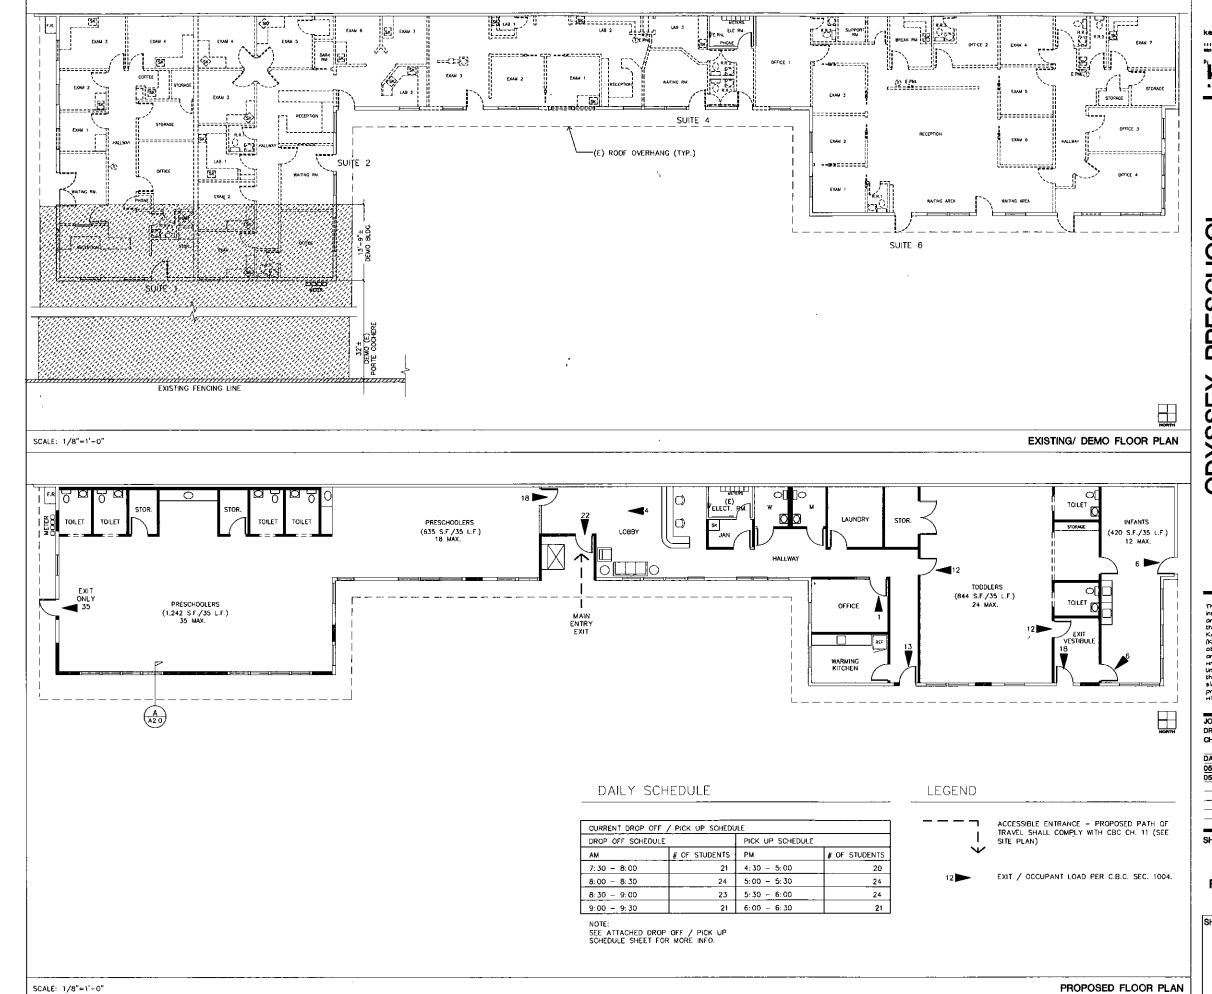
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SHEET TITLE:

**COVER SHEET** 

SHEET NUMBER:

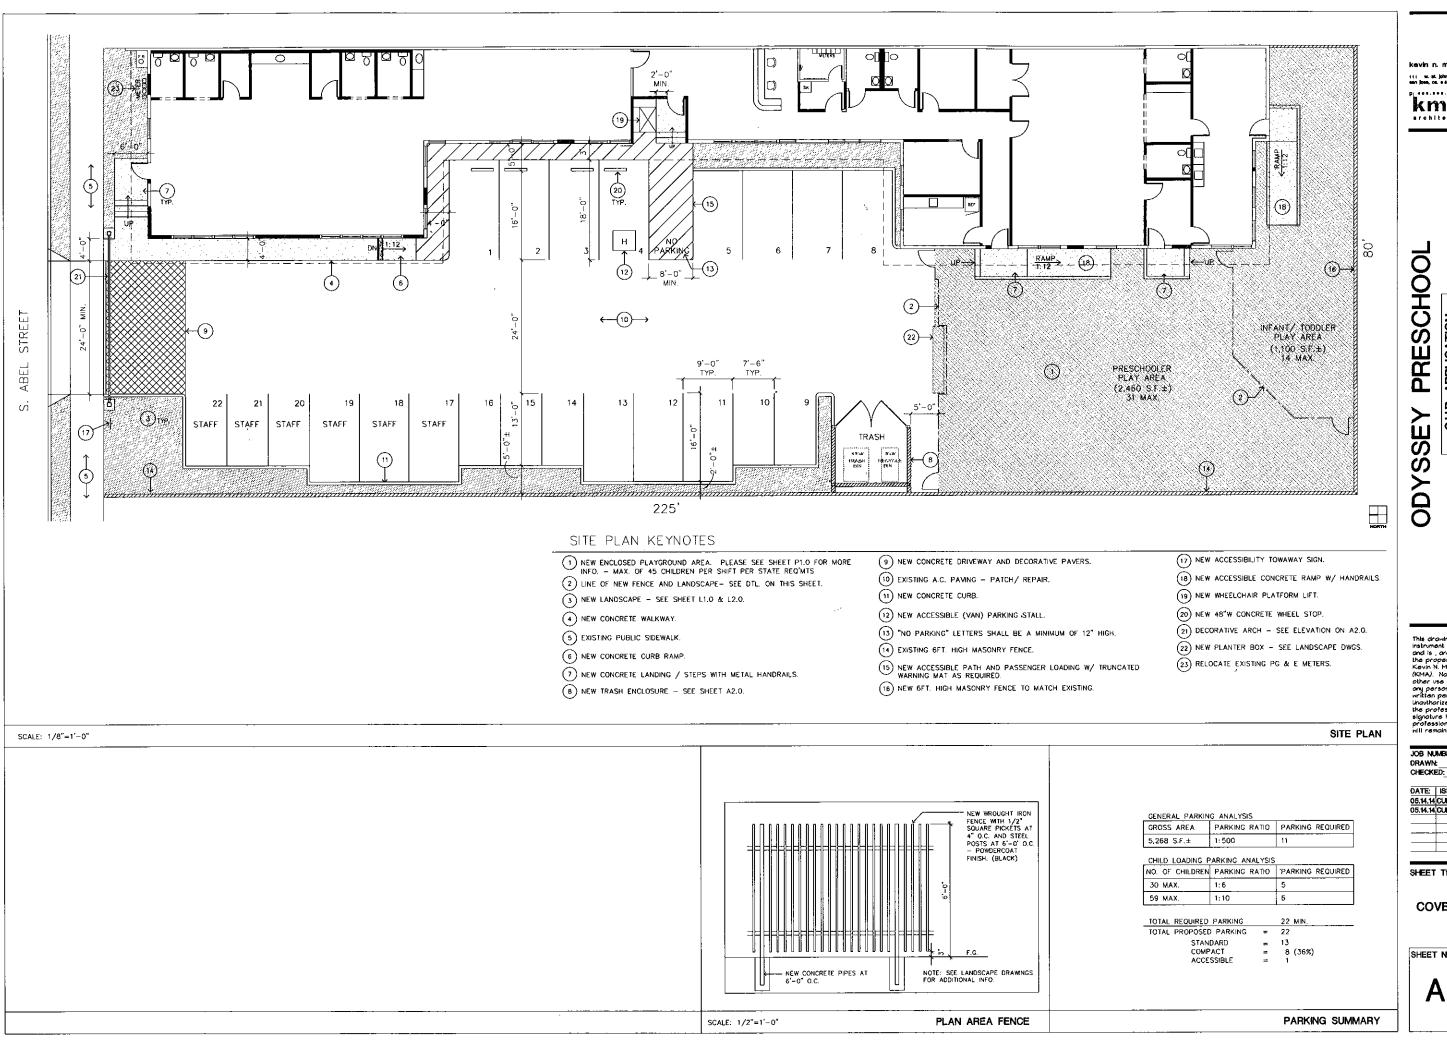A0.1



kevin n. mattos architect

404.909.4444 kma

architecture+dealgn

**PRESCHOOL** ODYSSEY

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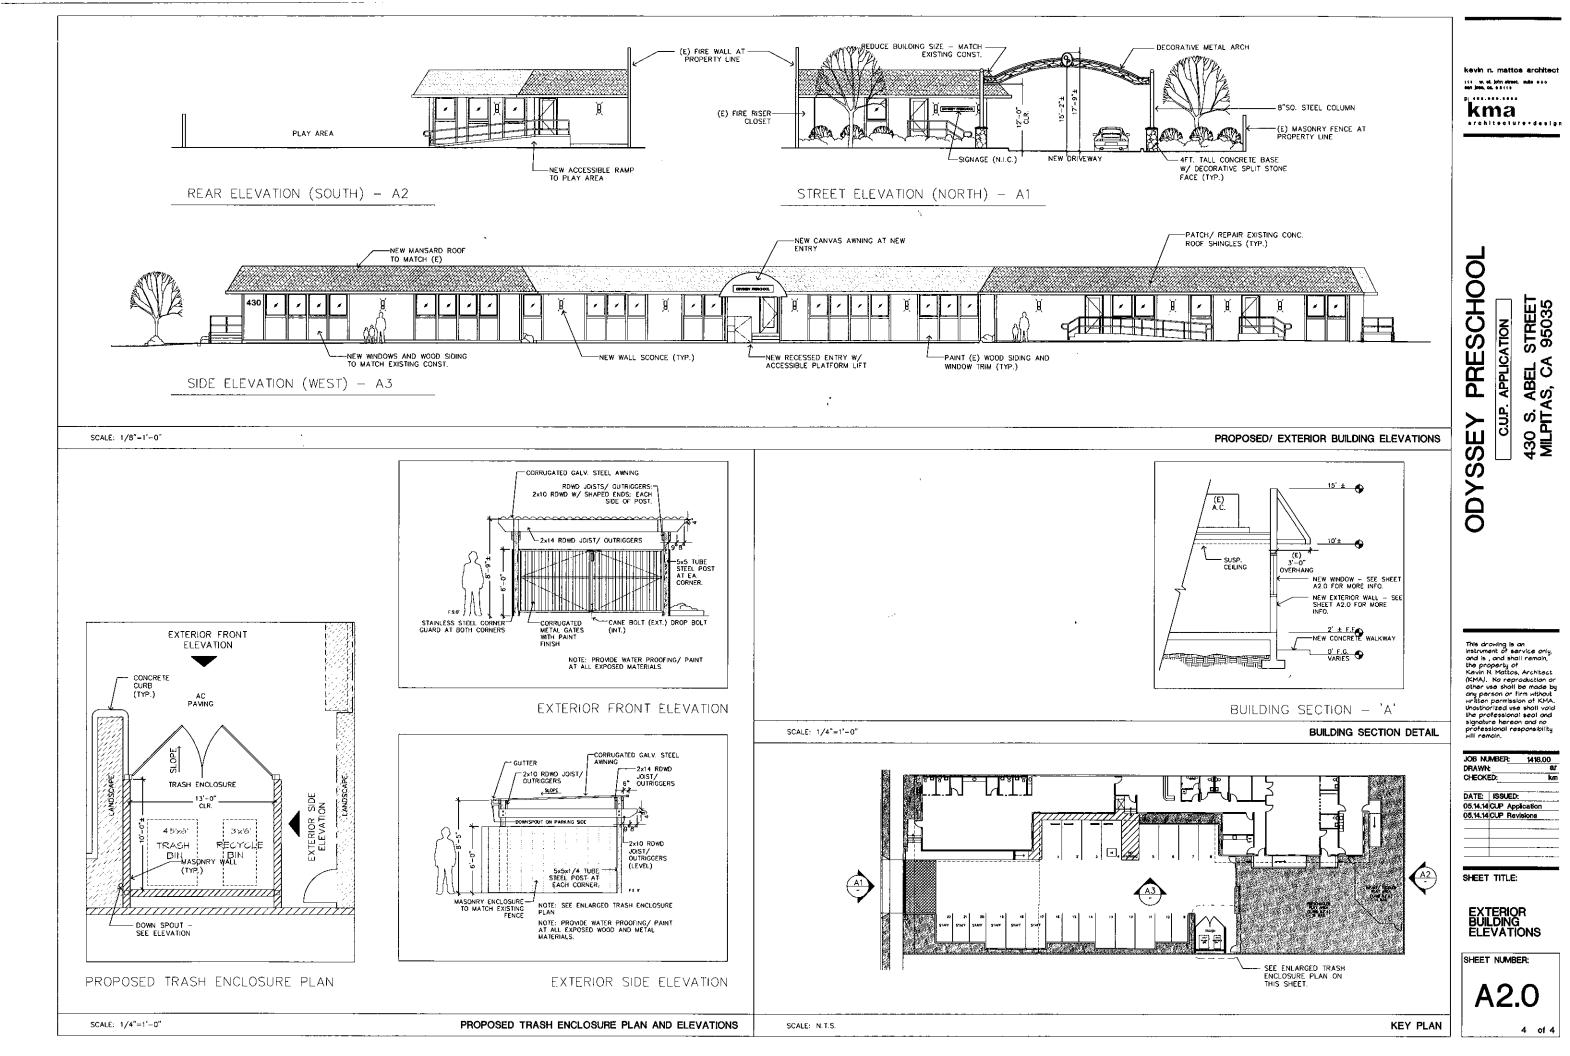
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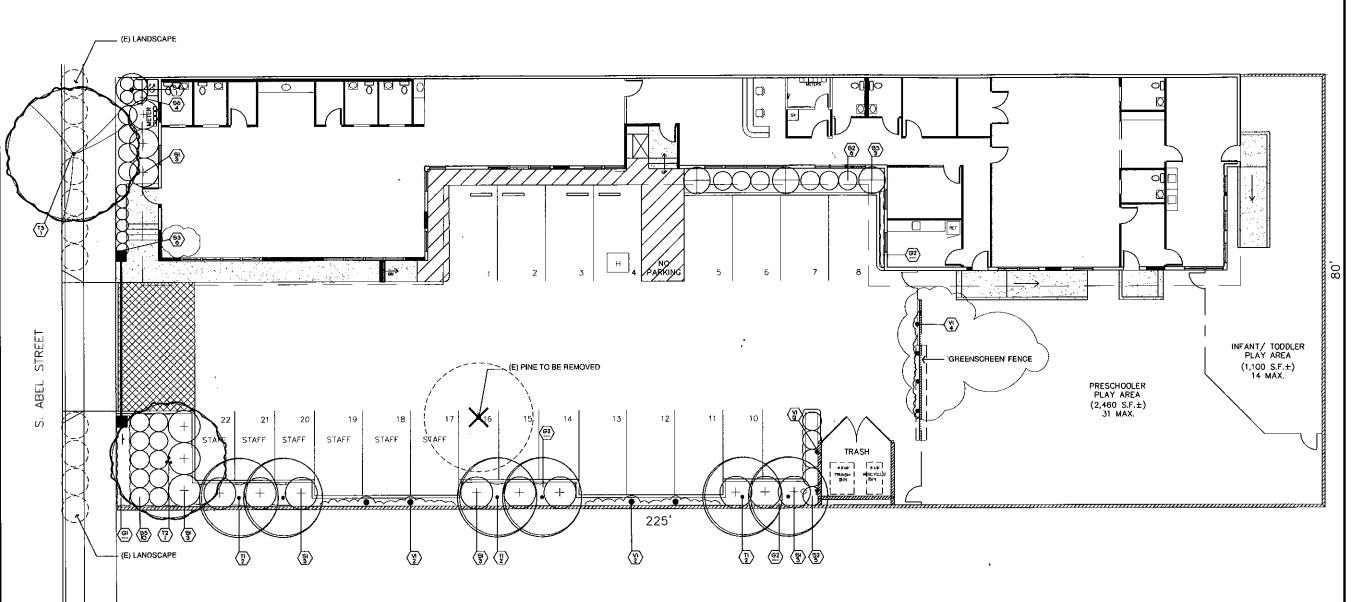
SHEET TITLE:

FLOOR PLANS

SHEET NUMBER:

A1.0







REED ASSOCIATES 477 SOUTH TAAFFE STREET SUNNYVALE, CALIFORNIA 94086 428,481-9020-408,481-9022 FAX nebt www.talanot / emelt pauligralanot

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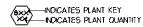



ŒΥ	BOTANICAL NAME	COMMON NAME	QTY.	SIZE	REMARKS	WUCQL
	TREES					
ΤÏ	TRISTANIOPSIS LAURINA	LITTLE LEAF MYRTLE	6		STANDARD	
Ť2	PISTACIA CHINESIS	CHINESE PISTACHE		24"BOX	STANDARD	LOW
Т3	GINKGO B. 'SARATOGA'	MAIDENHAIR TREE		15 GAL	STANDARD	MEDIU
	SHRUBS	<u> </u>		L		
Sì	PITTOSPORUM T. 'VARIEGATA'	MOCK ORANGE	15	5 GAL		LOW
52	RHAPHOLEPIS U. 'MINOR'	YEDDO HAWTHORN	II	5 GAL		LOW
93	NANDINA D. 'GULF STREAM'	GULF STREAM HEAVENLY BAMBOO	9	5 GAL		LOW
54	ARBUTUS U. 'COMPACTA'	STRAWBERRY TREE	ı	5 GAL		LOW
55	COLEONEMA P. 'SUNSET GOLD'	GOLDEN BREATH OF HEAVEN	Ю	5 GAL		MEDIU
96	AGAPANTHUS 'TINKERBELL'	VARIEGATED ULY OF THE NILE	4	5 GAL		MEDIU
	GROUND COVERS					
GI	MAHONIA REPENS	CREEPING MAHONIA		I GAL	24" O.C.	LOW
G2	TRACHELOSPERMUM ASIATICUM	ASIAN STAR JASMINE		1 GAL	24" O.C.	MEDIU

# PLANT NOTES:

- THE CONTRACTOR SHALL VERFY PLANT QUANTITIES FROM THE PLANTING PLAN. QUANTITIES SHOWN IN THE LEGEND ARE FOR CONVENENCE ONLY.
- 2. NOTFY THE LANDSCAPE ARCHTECT IMMEDIATELY IN THE EVENT OF ANY DISCREPANCES BETWEEN ACTUAL SITE CONDITIONS AND THE PLANTING PLAN.
- 3. PLANT GROUNDCOVER IN SHRUB AREAS AS NOTED, USE TRIANGULAR SPACING. 4. SEE DETAIL AND SPECIFICATION SHEETS FOR ADDITIONAL INFORMATION.
- THERE WILL BE NO MATERIALS OR PLANT MATERIALS SUBSTITUTIONS WITHOUT APPROVAL OF THE OWNER OR THE LANDSCAPE ARCHTECT.
- 6. PROVIDE POSITIVE DRAINAGE AWAY FROM ALL BULONGS (21 MIN)
- In the event of any discrepances between this plan and actual site conditions, the landscape architect is to be notifed immediately.
- ALL SITE UTILITIES ARE TO BE PROTECTED DURING CONSTRUCTION. IN THE EVENT OF CONFLICT BETWEEN THE PLANS AND UTILITIES THE CONTRACTOR SHALL NOTIFY THE LANDSCAPE ARCHITECT. ANY DAMAGE TO UTILITIES, STRUCTURES, OR OTHER FEATURES TO REMAIN, AND CAUSED ST THE LANDSCAPE CONTRACTOR SHALL BE REPLACED OR REPARED BY THE CONTRACTOR AT NO EXPENSE TO THE OWNER.
- THE WORK IN THESE DRAWINGS, AND SPECIFICATIONS MY RUN CONCURRENTLY WITH WORK BY OTHERS. THE LANDSCAPE CONTRACTOR SHALL COORDINATE THE WORK WITH OTHER CONTRACTORS.
- 10. PRIOR TO ANY DIGGING OR TRENCHING, CALL <u>UNDERGROUND SERVICE ALERT.</u>— 1800:227:2600

# PLANT SYMBOLS



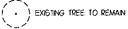


(X) EXISTING TREE TO BE REMOVED





**PLANTING PLAN** 

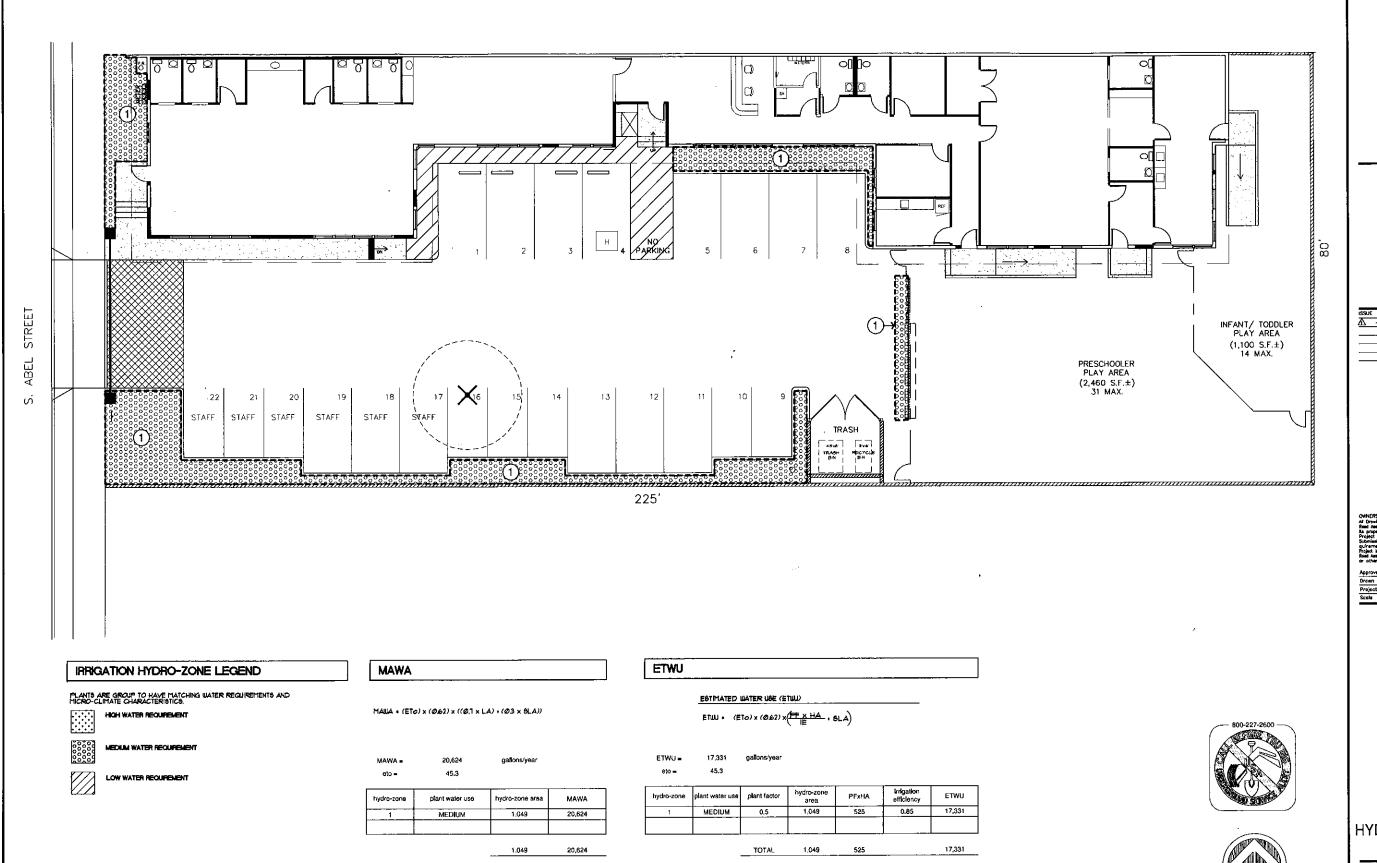

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SUNTYVALE, CALIFORNIA 94086
108,481-9020 408,481-9022 PAR
46tt www.nbunet / emit pe.4874bunet

ODYSSEY PRESCHOOL

430 S. ABEL ST. MILPITAS, CA 95035

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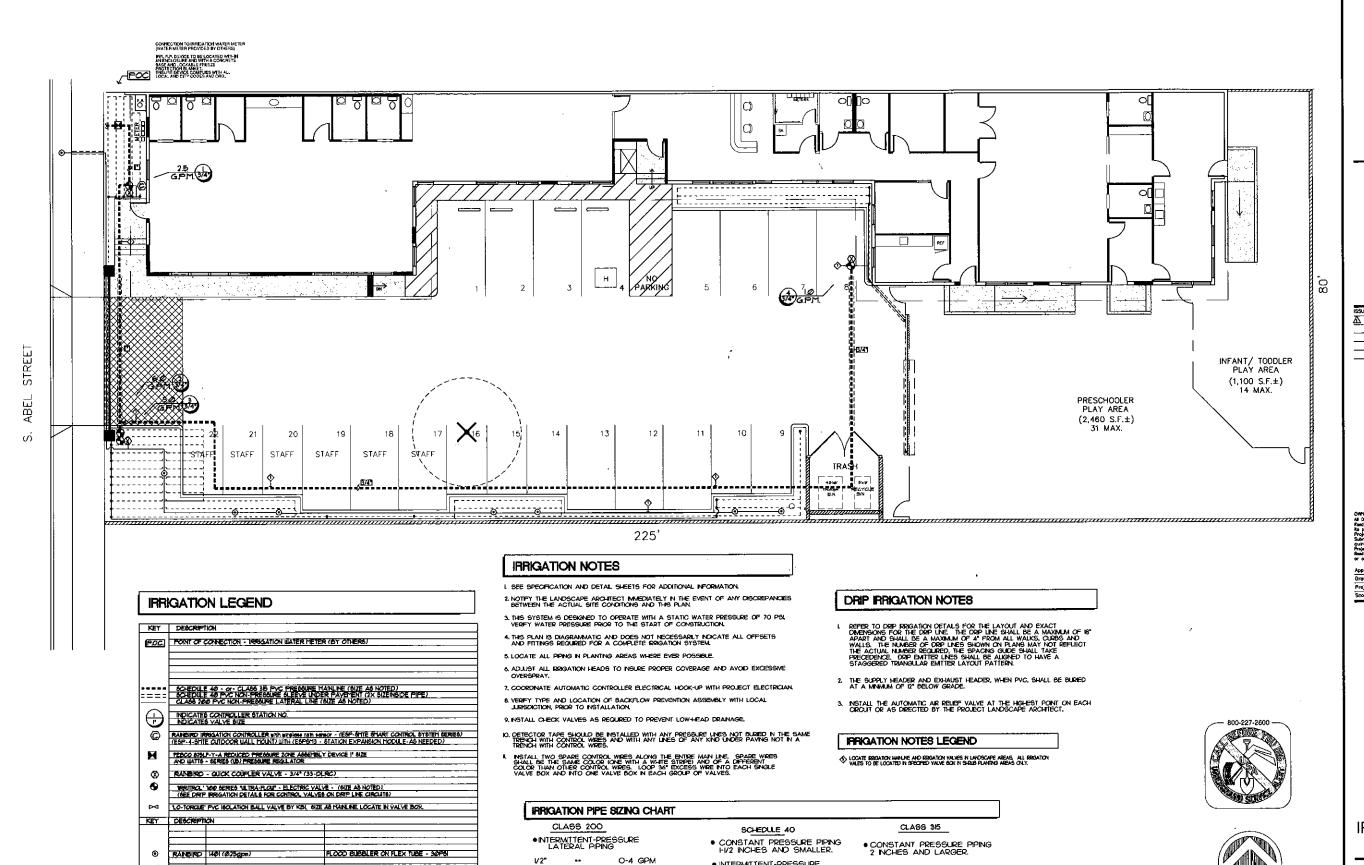
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 PUR

 Project No.
 14.27
 Scale 1/8"=1" Issue Dota 6.20.1:

LANDSCAPE HYDRO-ZONE PLAN

Scole 1" = 8 ft

L2.0



 INTERMITTENT-PRESSURE LATERAL PIPING

H/4\* ••

9-16 GPM

16-22 GPM

23-30 GPM

31-48 GPM

49-65 GPM

66-100 GPM

2-V2" ·

83 GPH DRPLNE AT B" SPACING CONTROL JOARSHLTER KTI - I' MAN FLOW OF 38 GPH) (SEE INSEATION DETAILS FOR ADDITIONAL INDRINATION INSTALL FIRS HANDACHINERY SPECIFICATIONS)

3/4"

**⊦**|/4"

F1/2"

5-9 GPM 10-16 GPM

17-26 GPM

27-35 GPM

36-55 GPM



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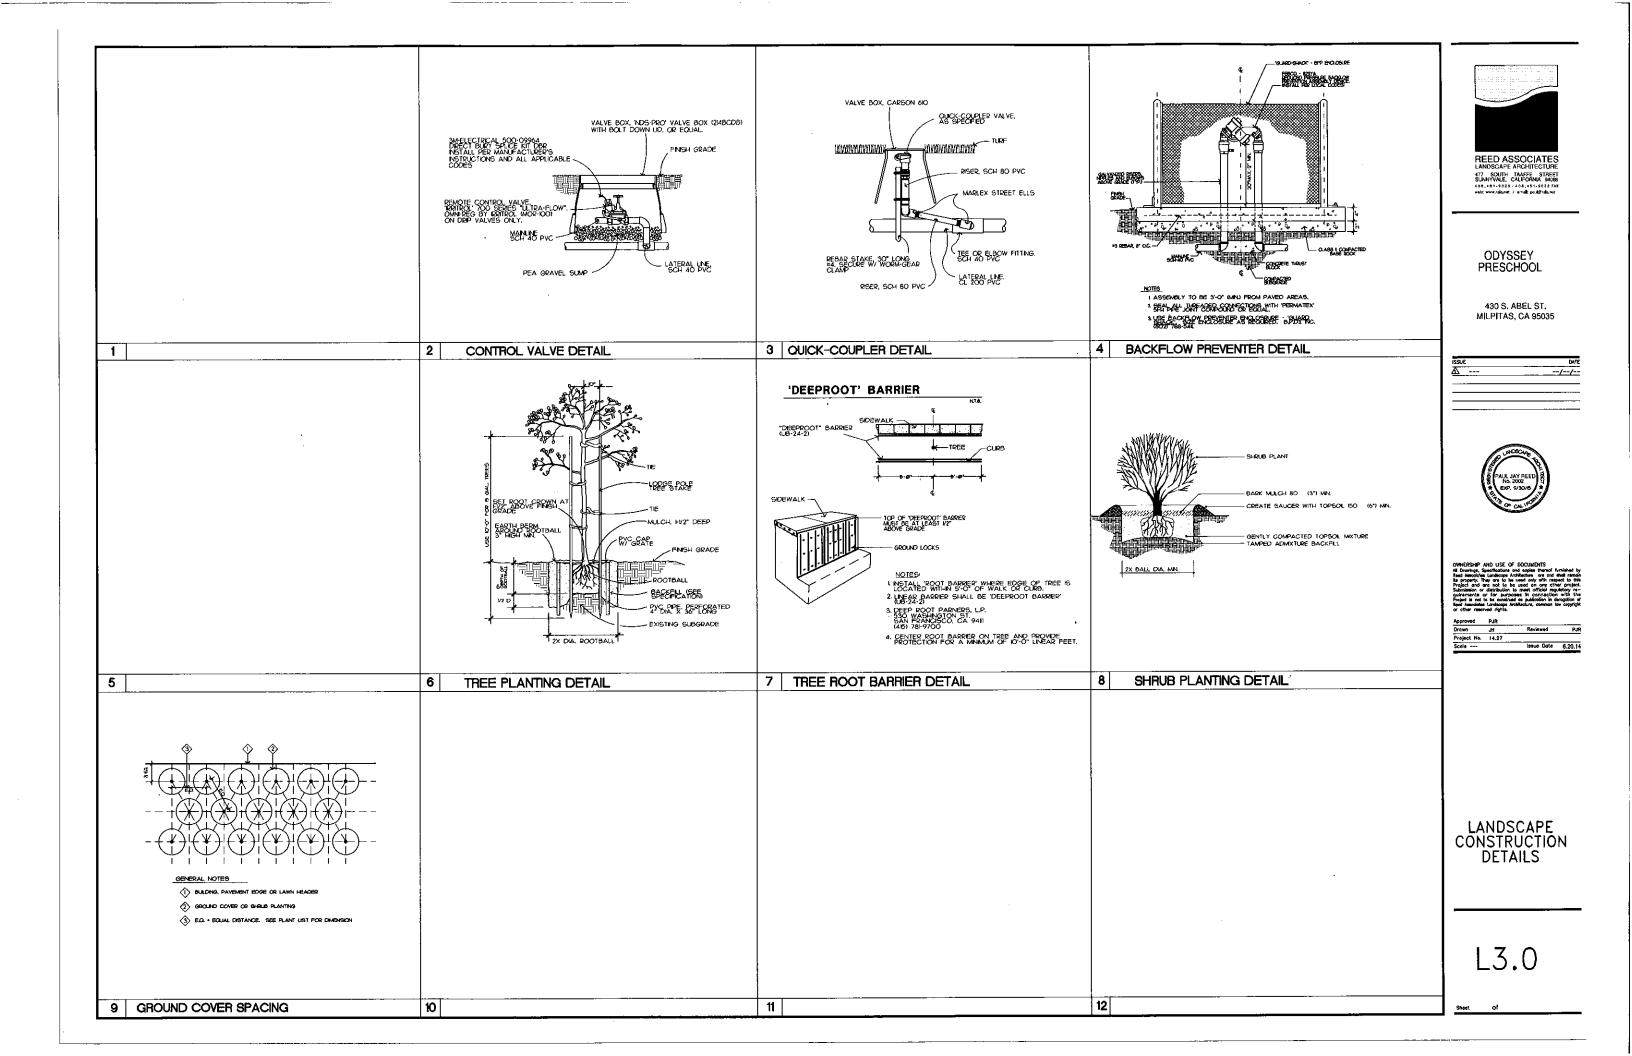
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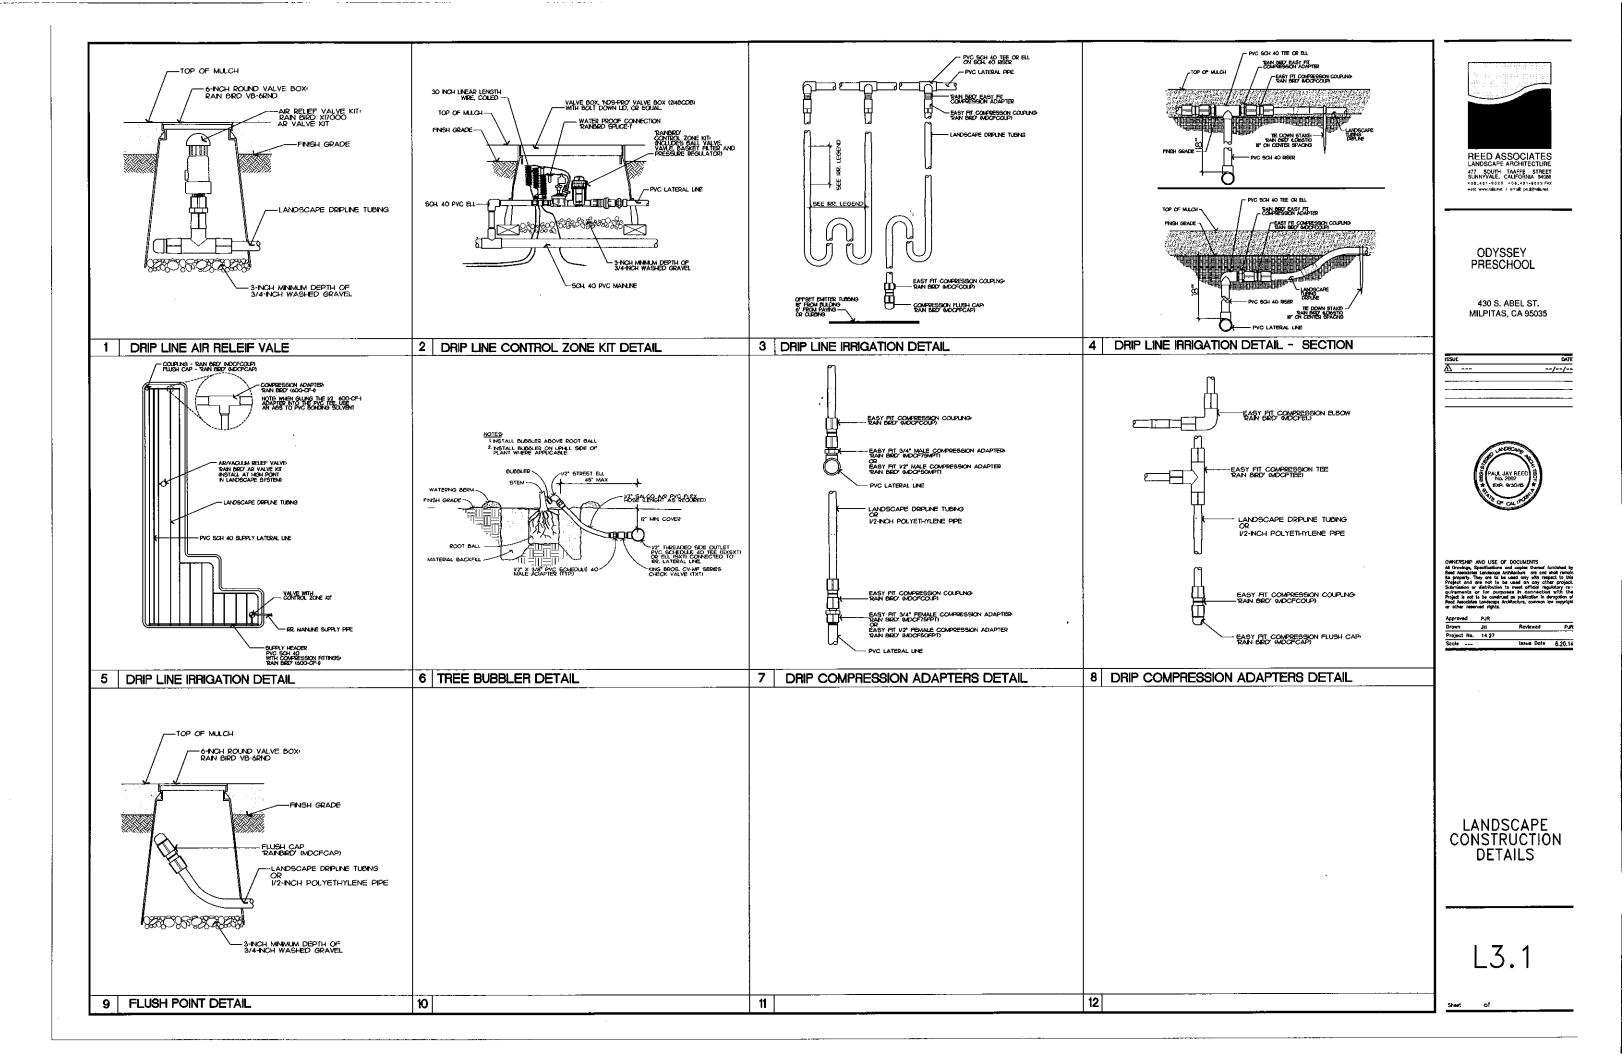
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LANDSCAPE IRRIGATION PLAN

L2.

LZ.





### LANDSCAPE SPECIFICATIONS

IRRIGATION SPRINKLER SYSTEM AND LANDSCAPE PLANTING

- THE WORK INCLUDES LABOR, MATERIALS, AND EQUIPMENT REQUIRED TO COMPLETE WORK INDICATED IN ORAWINGS AND DESCRIBED IN SPECIFICATIONS.
- PERFORM WORK IN ACCORDANCE WITH BEST STANDARDS OF PRACTICE RELATING TO VARIOUS TRADES, AND UNDER CONTINUOUS SUPERVISION OF A COMPONENT FOREMAN CAPABLE OF INTERPRETING DRAWINGS AND SPECIFICATIONS.
- PRIOR TO CONSTRUCTION, VERIFY THAT CONTRACT DOCUMENTS REFLECT LATEST REVISIONS, INCLUDING PIAN CHECK REQUIREMENTS.
- CONSTRUCT IRRIGATION SYSTEM USING MATERIAL AND METHODS CONFORMING TO APPLICABLE PROVISIONS OF UNIFORM PLUMBING CODE, PUBLISHED BY WESTERN PLUMBING OFFICIALS ASSOCIATION, NATIONAL ELECTRICAL CODE, AND OTHER CODES PROPERLY GOVERNING THESE ACTIVITIES AT THE LOCATION OF THE WORK.
- VERIFY LOCATIONS OF EXISTING UTILITIES WHETHER OR NOT SHOWN IN DRAWINGS ASSUME RESPONSIBILITY FOR THEIR PROTECTION.

- DIMENSIONS INDICATED IN DRAWINGS ARE APPROXIMATE. PROMDE OFFSETS, FITTINGS, SLEEVES, ETC., REQUIRED TO COMPLETE THE PROJECT. PERFORM SIMILAR OPERATIONS FOR LIKE CONDITIONS WITHOUT ADDITIONAL COST TO OWNER.

- FURNISH MATERIALS IN QUANTITIES, SIZE, AND MANUFACTURE INDICATED IN DRAWINGS AND SPECIFICATIONS.
- FOR A PERIOD OF 30 DAYS AFTER EXECUTION OF CONTRACT, LANDSCAPE ARCHITECT WILL CONSIDER FORMAL REQUESTS FROM CONTRACTOR FOR SUBSTITUTION OF PRODUCTS IN PLACE OF THOSE SPECIFIED ONLY UNDER THESE CONDITIONS.
- 1. WHEN SPECIFIED PRODUCTS ARE NOT AVAILABLE THROUGH NO FAULT OF SUB-CONTRACTOR
- WHEN IT IS CLEARLY SEEN, IN THE JUDGMENT OF OWNER, THAT A SUBSTITUTION WILL. BE TO OWNER'S BEST INTERESTS IN TERMS OF TIME, COST, OR OTHER CONSIDERATIONS.
- SUBLIT A SEPARATE REQUEST FOR EACH SUBSTITUTION. PREVORE COMPLETE DATA SUBSTANTAINO COMPLIANCE OF PROPOSED SUBSTITUTION, INCLUENG PRODUCT IDENTIFICATION, MANUFACTURER'S NAME AND ADDRESS, MANUFACTURER'S LITERATURE, AND SAMPLES AS APPLICABLE.
- manufacturer's warranties will not releve sub-contractor of his liability under the guarantee, only supplement the guarantee.
- FURNISH OWNER WITH A SET OF RECORD DRAWINGS (REPRODUCIBLE VELLUMS) OF IRRIGATION SPRINKLER SYSTEM AT CONCLUSION OF THE INSTALLATION.
- OBTAIN VELLUMS FROM LANDSCAPE ARCHITECT AT COST OF REPRODUCTION PLUS 25
  PERCENT.
- INDICATE IN RECORD DRAWINGS ALL CHANGES MADE TO IRRIGATION SYSTEM DESIGN. 1.3 EXTRA MATERIALS
- FURNISH OWNER WITH 2 EACH OF THE FOLLOWING MATERIALS FOR EACH TYPE OF VALVE AND SPRINKLER HEAD INSTALLED IN THE SYSTEM:

  - VALVE KEYS. SERNICE WRENCHES. QUICK COUPLER VALVE KEYS. HOSE SWYCLS COMPATIBLE WITH QUICK COUPLER VALVES. KEYS TO OPEN AUTOMATIC CONTROL CABINET.

- PRIOR TO INSTALLATION, LAYOUT AND STAKE PRESSURE SUPPLY LINES, LATERAL LINES, AND LOCATION OF SPRINKLER HEADS. OBTAIN APPROVAL LAYOUT FROM LANDSCAPE ARCHITECT.
- IF EQUIPMENT IS INCORRECTLY LOCATED WITHOUT APPROVAL, RELOCATE PER DIRECTIONS OF LANDSCAPE ARCHITECT WITHOUT ADDITIONAL COST TO DWINER
- 2. CONNECT SPRINKLER IRRIGATION SYSTEM TO POINT OF CONNECTION (P.O.C.) INDICATED IN DRAWINGS.
- MAKE CONNECTIONS AT APPROXIMATE LOCATIONS SHOWN IN DRAWINGS
- B. ASSUME RESPONSIBILITY FOR CHANGES CAUSED BY ACTUAL SITE CONDITIONS C. TRENCHING & BACKFILLING
- EXCAVATION INCLUDES REMOVAL OF WATER AND MATERIALS, OR OBSTRUCTIONS OF ANY NATURE THAT WOULD INTERFERE WITH THE WORK.
- REMOVE FROM THE SITE EXCESS AND WASTE MATERIAL RESULTING FROM TRENCHING OPERATIONS.
- 3. DIG TRENCHES STRAIGHT AND SUPPORT PIPE CONTINUOUSLY ON BOTTOM OF DITCH.
- A. LAY PIPE TO AN EVEN GRADE. FOLLOW LAYOUT FOR TRENCHING EXCAVATION INDICATED IN DRAWINGS AND AS NOTED.
- A. PROVIDE MINIMUM COVER OF 18 INCHES FOR PRESSURE SUPPLY LINES
- B. PROVIDE MINIMUM COVER OF 15 INCHES FOR ALL NON-PRESSURE LINES INDICATED IN DRAWINGS.
- C. PROVIDE MINIMUM COVER OF 24 INCHES OVER PIPE UNDER VEHICULAR WAYS.
- D. PROVIDE MINIMUM COVER OF 18 INCHES FOR CONTROL WIRING
- PROVIDE 3 INCH SAND BACKFILL, ALL SIDES OF PVC PIPE, WHERE SOILS CONTAIN GREATER THAN 50% ROCKS OR OTHER MATERIAL 1/2 INCH OR LARGER IN DIAMETER WITHIN MATTYE BACKFILL MATERIAL.

# D. COMPACTION

- COMPACT BACKFILL FOR TRENCHING TO A DRY DENSITY EQUAL TO ADJACENT UNDSTURBED SOIL IN PLANTING AREAS AND TO 90% IN PAVED AREAS.
- 2. CONFORM TO ADJACENT GRADES WITHOUT DIPS, SUNKEN AREAS, HUMPS, OR OTHER PREGULARITIES.
- FOREIGN MATTER LARGER THAN 1/2 INCH IN SIZE WILL NOT BE PERMITTED.
- F SETTLEMENT OCCURS AND ADJUSTMENTS IN PIPE, VALVES, SPRINKLER HEADS, LAWN OR PLANTING, OR OTHER CONSTRUCTION ARE NECESSARY, MAKE REQUIRED ADJUSTMENTS WITHOUT ADDITIONAL COST TO OWNER.
- E. HANDLING OF PIPE
- INSTALL PVC PIPE ALLOWING A SMALL AMOUNT OF EXCESS LENGTH IN THE LINE TO COMPENSATE FOR CONTRACTION OR EXPANSION OF THE PIPE.
  - A. ACCOMPLISH EXCESS LENGTH BY "SNAKING" THE LINE IN THE TRENCH DURING TIME OF INSTALLATION.
- HANDLE AND ASSEMBLE PIPE, FITTINGS, AND ACCESSORIES BY SKILLED TRADESMEN USING APPROVED METHODS AND TOOLS. EXERGISE CARE TO PREVENT DAMAGE TO MATERIALS OR FOUIPMENT.
- A. KEEP INTERIOR OF PIPES, FITTINGS, AND ACCESSORIES CLEAN AT ALL TIMES. CLOSE OPENINGS IN PIPING RUNS AT THE END OF WORK EACH DAY TO PREVENT ENTRY OF FOREIGN MATERIALS.
- 3. PERFORM JOINTING BY COMPETENT TRADESMEN SPECIALLY TRAINED IN THE TYPE OF WORK REQUIRED, USING TOOLS AND EQUIPMENT RECOMMENDED BY THE MANUFACTURERS OF THE PIPE, PITTINS, OR EQUIPMENT.
- TAKE EVERY PRECAUTION TO SECURE A PERMANENT, WATER-TIGHT JOINT BETWEEN EACH LENGTH OF PIPE.
- B. JOINTING PROCEDURES AND METHODS ADOPTED BY CONTRACTOR SHALL BE IN STRICT ACCORDANCE WITH RECOMMENDATIONS OF MANUFACTURER OF JOINTING MATERIAL USED.

- FURINSH OWNER WITH GURANIEE THAT IRRIGATION SPRINGER SYSTEM IS FREE FROM DEFECTS IN MATERIAS AND VORKUMSHIP! AND THE WORK HAS GEEN COMPLETED IN ACCORDANCE WITH DRAWINGS AND SPECIFICATIONS, ORDINARY WEAR AND TEAR, LINUISUAL ABUSE, OR NEGLECT ACCEPTED.
- PROMOS GUMANNEE FOR REPAIR OR REPLACEMENT OF DEFECTS IN MATERIAL OR WORKMANSHIP SETTING OF BACKFLIED TREMCHES, AND TO REPAIR OR REPLACE DAMAGE RESULTING FROM THE REPAIRS OR REPLACEMENTS OF DEFECTS WITHOUT ADDITIONAL COST TO OWNER.
- MAKE REPAIRS OR REPLACEMENTS, INCLUDING COMPLETE RESTORATION OF CAMAGED PLANTING, PANNIG, OR OTHER IMPROVALENTS OF ANY KIND, MITHIN A REASONABLE TIME AS DETERMINED BY OWNER, AFTER RECEIPT OF WRITTEN NOTICE.
- IN THE EVENT OF FAILURE BY CONTRACTOR TO MAKE REPAIRS OR REPLACEMENTS WITHIN / TEN DAYS AFTER RECEIPT OF WRITTEN NOTICE, REPAIRS OR REPLACEMENTS WILL BE MADE BY OTHERS AT THE EXPENSE OF SUB-CONTRACTOR.
- WARRANTY PERIOD FOR IRRIGATION SPRINKLER SYSTEM, 1 YEAR FROM DATE OF ACCEPTANCE BY OWNER.
- 1.5 LANDSCAPE MAINTENANCE AND GUARANTEE
- PROVIDE MAINTENANCE FOR PLANTING AND IRRIGATION FOR 60 CALENDAR DAYS AFTER STAGE ACCEPTANCE.
  - WORK INCLUDES, BUT IS NOT LIMITED TO, WATERING, WEEDING, MOWING, FERTILIZING, OLUTIVATING, SPRAYING, CUTTING, AND PRUNING NECESSARY TO KEEP PLANTS IN A HEALTHY GROWING CONDITION, AND TO KEEP PLANTED AREAS NEAT AND ATTRACTIVE IN APPERAMICE THROUGHOUT MAINTERNANCE PERIOD.
  - IMMEDIATELY REPLACE CAMAGED, UNHEALTHY, OR DEAD TREES, SHRUBS, AND GROUND COVERS WITH SIZE AND KIND INDICATED IN DRAWINGS.
  - PRIOR TO END OF MAINTENANCE PERIOD, APPLY FERTILIZED '0' (15-2-6) AT THE RATE OF 4 POUNDS PER 1,000 SQUARE FEET UNIFORMLY OVER ALL PLANTING AREAS.
  - UPON COMPLETION OF INITIAL SO DAY MAINTENANCE PERIOD, NOTIFY LANDSCAPE ARCHITECT 48 HOURS PROR TO DATE OF INITIAL INSPECTION.
- GUARANTEE THAT PLANTS AND PLANTING AREAS ARE IN HEALTHY, THRIMMIG CONDITION FOR AN ADDITIONAL BO DAYS AFTER INITIAL ACCEPTANCE OF PROJECT BY LANDSCAPE ARCHITECT
- FINAL ACCEPTANCE MAY BE GRANTED AT THIS TIME AS DETERMINED BY LANDSCAPE ARCHITECT. 2.0 PRODUCTS
- 2.1 IRRIGATION SPRINKLER MATERIALS
- A. PVC PLASTIC PIPE AND FITTINGS
  - NAIN LINE (PRESSURE) PIPING, TYPE 1120-1220 SCHEOULE 40, NSF APPROVED, LASCO, JOHNS MANVILLE, OR APPROVED EQUAL.
  - A. MAIN LINE PVC PIPE FITTINGS, TYPE 1-11 SCHEDULE 40, NSF APPROVED.
  - LATERAL (NON-PRESSURE) LINE PIPING, TYPE 1120-1220 SCHEDULE 40, CLASS 200, NSF APPROVED, LASCO, JOHNS MANMILLE, OR APPROVED EQUAL.
  - LATERAL PVC PIPE FITTINGS, TYPE 1-11 SCHEOULE 40, NSF APPROVED, LASCO, SLOANS, OR APPROVED EQUAL.
  - 3. SOLVENT, TYPE APPROVED BY MANUFACTURER OF PIPE AND FITTINGS. USE SCHEDULE 80 PVC THREADED NIPPLES IN RISER ASSEMBLIES.
  - USE ONLY PVC PLASTIC PIPE FREE FROM BUISTERS, INTERNAL STRIATIONS, DENTS, WRINKLES, CRACKS, HOLES, FOREIGN MATERIALS, SMOOTH INTERIOR WALL WITH A GLASS-UKF APPEARANCE.
- A CONTINUOUSLY AND PERMANENTLY MARK EACH PIPE WITH MANUFACTURER'S NAME, KIND OF PIPE, MATERIAL SIZE SCHEDULE OR TYPE, AND MANUFACTURER'S OUALITY COMPROL DOWNING ATTOM
- B. GALVANIZED PIPE AND FITTINGS
  - WHERE INDICATED IN DRAWINGS, USE ASA SCHEDULE 40 MILD STEEL SCREWED PIPE, GALVANIZED, WITH MEDIUM GALVANIZED SCREWED BEADED MALLEABLE IRON FITTINGS.
  - A. GALVANIZED COUPLINGS MAY BE MERCHANT COUPLING.

- O. AFTER CUTTING, REAM OUT ENDS TO THE FULL INSIDE DIAMETER OF THE PIPE.
- E. IN CHANGING PIPE DEPTHS, USE 450 ELBOWS.

- INSTALL TURF HEADS, WHERE ADJACENT TO FIXED OBJECTS SUCH AS HEADERBOARDS, CURBS, OR MOWING STRIPS, SO POWERED EDGING TOOLS CAN PASS BETWEEN TURF HEAD AND FIXED OBJECT WITHOUT DEFICULTY.
- LOCATE SHRUB HEADS MINIMUM 12 INCHES FROM BACK OF CURBS AND EGGE OF WALKWAYS WHEN SHRUB HEAD IS MOUNTED ABOVE GRADE ON A RISER.
- INSTALL ELECTRIC, NORMALLY CLOSED ANGLE CONTROL VALVES AS INDICATED IN DRAWINGS AND AS SPECIFIED BY MANUFACTURER.
- SET VALVES IN VERTICAL POSITION, HOUSED IN AMETEK OR EQUAL VALVE BOX WITH REMOVABLE COVER, FLUSH WITH FINISHED GRADE. WHEREVER POSSIBLE, INSTALL IN A SHRIJE AFFA.

- PERFORM ELECTRICAL WORK IN ACCORDANCE WITH THE NATIONAL ELECTRICAL CODE, THE STATE OF CALIFORNIA ELECTRICAL SAFETY ORDERS, OTHER APPLICABLE STATE AND LOCAL CODES AND REGULATIONS.
- ASSUME RESPONSIBILITY FOR THE COORDINATION OF ALL ELECTRICAL SERVICE CONNECTIONS TO THE CONTROLLER.

- FLUSH PIPES BY REMOVING HEADS AND OPERATING THE SYSTEM AT FULL PRESSURE UNTIL ALL RUST, SCALE, SAND, ETC., IS REMOVED.
- A. DIVERT FLUSHING WATER TO PREVENT PONDING OR SOIL EROSION TEST PIPING UNDER FULL PRESSURE, WITH RISERS CAPPED FOR A PERIOD OF TWO HOURS.
- A. CORRECT ANY LEAKAGE DISCOVERED DURING TESTS.

- A. TO DETERMINE THAT THEY FUNCTION ACCORDING TO MANUFACTURER'S DATA, AND
- B. TO DETERMINE THAT THE INSTALLATION WILL PROVIDE DESIGN COVERAGE ALLOW OR CAUSE WORK TO BE COVERED UP OR ENCLOSED ONLY AFTER IT HAS BEEN INSPECTED, TESTED, AND APPROVED BY LANDSCAPE ARCHITECT.
- A. SHOULD ANY WORK BE CLOSED OR COVERED UP BEFORE INSPECTION AND TESTS ARE SATISFACTIONLY COMPLETED, UNCOVER THE WORK, AND AFTER IT HAS BEEN INSPECTED, TESTED, AND APPROVED, MAKE ALL REPORTS WITH MATERIALS AS MAY BE RECESSARY TO RESTORED STURBED WORK TO ITS ORIGINAL AND PROPER CONDITION WITHOUT ADDITIONAL COST TO OWNER.

- 1. PRESERVE EXISTING TREES IN AN UNDISTURBED CONDITI
- CONSTRUCT MOUNDS WITH ENOUGH EXCESS MATERIAL TO ALLOW FOR FUTURE SETTLEMENT. A. FINAL LOCATION OF MOUNDS SHALL NOT CONFLICT WITH EXISTING UTILITIES, UTILITY BOXES, VALVE BOXES, ETC.
- NO COMPACTION WILL BE ALLOWED, EXCEPT FOR NORMAL GRADING AND SHAPING OPERATIONS.
- UPON COMPLETION OF GRADING OPERATIONS, SPREAD EXCESS MATERIAL IN AREAS DIRECTED BY LANDSCAPE ARCHITECT.
- 1. CULTIVATE PLANTED AREAS TO A LIGHT AND FRIABLE CONSISTENCY. UNIFORMLY TILL THE

### C. CONTROL WIRE

- DIRECT BURIAL REMOTE CONTROL WIRES, U.L. APPROVED TYPE U.F. MINIMUM OF 4/84 INCH MINT. INSULATION. CONSULT VALVE MANUFACTURER'S CURRENT WIRE SIZING CHART FOR REQUIRED WIRE SIZES.
- 2. COMMON RETURN WIRE WHITE, PILOT WIRE RED, ORANGE, OR BLACK.
- 3. MAKE SPLICES WITH "SCOTCH LOK" NO. 3577 CONNECTOR SEALING PACKS, OR APPROVED EQUAL.
- D. SPRINKLER HEADS, REMOTE CONTROL VALVES, AUTOMATIC CONTROLLER, QUICK COUPLER
  - 1. TYPE, SIZE, AND LOCATION INDICATED IN DRAWINGS

# LOCATE REMOTE CONTROL VALVES AND QUICK COUPLERS A MAXIMUM OF 12 INCHES FROM CURB, WALK, OR HEADERBOARD.

- BACKFLOW PREVENTERS AS INDICATED IN DRAWINGS OR AS APPROVED BY LOCAL GOVERNING BODY.
- SCREEN UNIT WITH PLANT MATERIAL SHOWN ON PLANTING PLAN IN LOCATION OF BACKFLOW PREVENTER OR ELSEWHERE ON SITE WHEN DIRECTED BY LANDSCAPE ARCHITECT.
- 4. AVOID USING PVC PIPING IN BACKFLOW PREVENTER ASSEMBLIES.

- CONTROL VALVE BOXES, AMETEX NO. 10-70-00 WITH GREEN COVER LID NO. 10-173-004, OR EQUAL. PROVIDE EXTENSIONS IF REQUIRED.

- EXISTING SURFACE SOIL UNLESS OTHERWISE INDICATED IN DRAWINGS, FREE FROM SUBSOIL, REFUSE, ROOTS, HEAVY OR STIFF CLAY, ROCKS, STICKS, BRUSH OR OTHER DELETERIOUS MATERIALS.
- NATIVE SOIL, MATERIAL EXCAVATED FROM PLANTING HOLES, FREE FROM ROCK OVER 1/2 INCH IN DIAMETER.
- - SUBMIT SOIL SAMPLES AND ANALYSIS OF IMPORTED SOIL TO LANDSCAPE ARCHITECT FOR APPROVAL PRIOR TO DELIVERY TO PROJECT SITE.
- SHOULD LANDSCAPE ARCHITECT REJECT ANY PORTION OF DELIVERED SOIL, FOR ANY REASON, SELECT SOIL MATERIAL, FROM A DIFFERENT SOURCE AND RESUBBIT TO LANDSCAPE ARCHITECT FOR APPROVAL WITHOUT ADDITIONAL COST TO OWNER.

### B. FERTILIZERS AND SOIL AMENDMENTS

- COMMERCIAL GRADE FERTILIZERS AND SOIL AMENDMENTS, UNIFORM IN COMPOSITION, DRY AND FREE-FLOWING, DELIVERED TO SITE IN ORIGINAL, UNOPENED CONTAINERS, EACH BEARING THE MANUFACTURER'S GUARANTEED ANALYSIS.
- MATERIAL WHICH BECOMES CAKED OR OTHERWISE DAMAGED, MAKING IT UNSUITABLE FOR USE, WILL BE REJECTED.
- A FERTILIZÉR 'A': FERTILIZER FOR GENERAL SOIL FERTILITY IMPROVEMENT IN ALL TURK ANNO AND SMALL BE PELLETED TYPE HAVING A NO-P2O-K20 FORMULA.
- B. FERTILIZER 'B': FERTILIZER TO BE APPLIED TO LAWN AREAS PRIOR TO SEEDING OR SOODING SHALL BE PELLETED TYPE HAMNO N6-P2-KO (WITH 1% RON).
- C. FERTILIZER 'C': FERTILIZER TO BE INCORPORATEO IN EACH PLANT PIT SHALL
  BE A FLANT TAB WITH FORMULA N20-P10-KS, SUCH AS
  AGRIFORM.
- E. SOIL AMENOMENT: RECYCLED COMPOST MATERIAL,

# 7

- FOLLOWING MATERIAL, PER 1,000 SQUARE FEET, INTO THE TOP 6 INCHES OF SOIL, USING A ROTOTILLER OR SIMILAR MACHINE, THEN THOROUGHLY WATER.
- 3. PREPARED SOIL MIX FOR BACKFILL IN PITS FOR TREES, VINES, AND SHRUBS, CONSISTING OF THE FOLLOWING:
- 1/3 yd. Recycled Compost Material (soil Amendment) 2/3 yd. Native Soil 1 lb. Iron Sulphate
- AND FERTILIZER "C" AS FOLLOWS
- CONDUCT SOIL PREPARATION AND PLANTING OPERATIONS ONLY UNDER FAVORABLE WEATHER CONDITIONS. SOIL SHALL NOT BE WORKED WHEN EXCESSIVELY DRY OR WET.
- LANDSCAPE ARCHITECT RESERVES THE RIGHT TO STOP WORK TAKING PLACE DURING A PERIOD WIEN CONDITIONS ARE CONSIDERED DETRIMENTAL TO SOIL STRUCTURE OR PLANT GROWTH.
- C. PLANTING TREES, SHRUBS, & VINES
  - A LEVEL SIZE OF PITS SHALL BE 2 TIMES CHAMETER OF ROOT BALL, AND ONE-HALF AGAIN AS DEEP AS THE DEPTH OF ROOT BALL.
  - B. SOIL AT SIDES AND BOTTOMS SHALL BE LOOSENED BY SCARIFYING TO ENSURE ROOT PENETRATION. AVOID SMOOTH CIRCULAR SIDES.
  - BACKFILL PITS WITH "PREPARED SOIL" TO THE BOTTOM OF THE ROOT BALL. THEN SET THE PLANT IN AN UPRIGHT POSITION IN CENTER OF HOLE. BACKFILL SPACE AROUND IT WITH PLANTING MILE.
  - A. WHEN THE BACKFILL AROUND THE PLANT IS APPROXIMATELY TWO—THIRDS COMPLETED, THOROUGHLY WATER. BACKFILL COMPLETE TO THE GRADE OF THE SURPRINDING ARPA.
  - B. THE CROWN OF THE PLANT SHALL BE 1-1/2 INCHES ABOVE (MINIMUM) FINISHED GRADE. PREPARE A SOIL RING AT LEAST J INCHES HIGH AND AS WIDE AS ROOT BALL AROUND EACH PLANT (NOT IN A TURF AREA) TO RETAIN WATER.
  - B. REMOVE TURF IN A 24 INCH DIAMETER RING AROUND EACH TREE BASE IN TURF AREAS.
  - PLANTING SHALL TAKE PLACE IN THE EXISTING PREPARED MOIST AND FRIABLE SOIL, NEVER DRY OR WET AND SOGGY.
  - A. THE MOIST CONDITION SHALL EXTEND TO THE FULL DEPTH OF CULTIVATION
- 2. SPACE GROUND COVER PLANTS AS INDICATED IN DRAWINGS AND IN THE PLANT LIST PLANT IN EVENLY SPACED ROWS WITH STAGGERED TRIANGULAR SPACING AND AROUND SHRUBS AND TREES TO WITHIN ONE FOOT.
- 4. NO GROUND COVER SHALL BE PLANTED LESS THAN ONE-HALF OF THE SPECIFIED SPACING
  FROM ANY CURB OR WALKWAY.
- AFTER ALL SOIL AMENDMENT AND FERTILIZERS HAVE BEEN APPLIED AND CULTIVATED INTO SOIL, FINE GRADE ALL AREAS. REMOVE RIGGES AND DEPRESSIONS, AREAS SHALL BE SMOOTH, CONTINUOUS, FIRM PLANES THAT ENSURE PROPER SURFACE DRAINAGE.
- REMOVE ROCKS, SON LUMPS, AND DELETEROUS MATERIALS LARGER THAN 1 INCH, RAKE AND COMPACT AREAS WITH A 200 POUND ROLLER. AYOID ADDITIONAL COMPACTION OF THE SOILS AFTER TREATMENT. DO NOT PERMIT
  VEHICULAR OR EQUIPMENT TRAFFIC OVER AREAS.

- F. IRON SULFATE:
- C. WOOD CHIP MULCH
- ALL PLANTED AREAS, EXCEPT TURF, SHALL RECEIVE A TOP DRESSING OF MULCH CONSISTING OF RECYCLED , DYED WOOD CHIPS OR FIR CHIPS, MEDIAN GRIND 3/8 TO 3/4" DIAMETER. SHREDDED BARK IS UNACCEPTABLE.

### D. PLANT MATERIAL

- CONFORM PLANT MATERIAL, INDICATED IN DRAWINGS BY THE LISTED NAMES, TO "STANDARD PLANT NAMES", SECOND EDITION. EXCEPT FOR NAMES NOT INCLUDED, FOLLOW THE ESTABLISHED CUSTOMS OF THE NURSERY TRADE.
- ALL PLANTS SHALL BE TRUE TO NAME. TAG DINE OF EACH BUNDLE OR LOT WITH THE NAME AND SIZE OF THE PLANT, IN ACCORDANCE WITH STANDARDS OF PRACTICE RECOMMENDED BY AMERICAN ASSOCIATION OF NURSERYMEN.
- ALL PLANT MATERIALS SHALL MEET THE SPECIFICATIONS OF FEDERAL, STATE, AND COUNTY LAWS, REQUIRING INSPECTION FOR PLANT DISEASES AND INSECT INFESTATIONS.
- PLANTS SHALL BE SYMMETRICAL TYPICAL FOR VARIETY AND SPECIES, SOUND, HEALTHY, VIGGOUS, FREE FROM PLANT IDSEASES, INSECT PESTS. OR OTHER EGGS. WITH HEALTHY, NORMAL ROOT SYSTEMS, WELL FILLING THEIR CONTAINERS, BUT NOT TO THE POINT OF BEING ROOT BOUND.
- USE ONLY PLANT MATERIALS THAT ARE FIRST CLASS REPRESENTATIVE OF THE SPECIES AND CULTIMATE SPECIFIED AND THAT CONFORM TO ALL STATE AND LOCAL LAWS COVERNING THE SULE, TRANSPORTATION, AND INSPECTION OF PLANT MATERIALS.
- PROMDE ONLY PLANTS WITH STRAIGHT, SINGLE TRUNKS, UNLESS OTHERWISE INDICATED IN DRAWINGS.
- THOSE SPECIFIED TO BE MULTI-TRUNK SHALL HAVE AT LEAST THREE MAIN LEADERS FROM THE BASE.
- PLANTS THAT HAVE ENCIRCLING ROOTS, NOT ROOT BOUND, SHALL HAVE ROOTBALLS LIGHTLY SLASHED ON A MINIMUM OF 3 SIDES TO STOP ENCIRCLING ROOT GROWTH.
- THE HEIGHT AND SPREAD OF PLANT MATERIALS SHALL BE MEASURED WITH BRANCHES IN THEIR NORMAL POSITION. MEASURE SIZES OF PLANTS ON THE PLANT LIST.
- A. 5 AND 15 GALLON CAN CONTAINER STOCK SHALL HAVE BEEN GROWN IN THA CONTAINER NOT LESS THAN SIX (6) MONTHS, BUT SHALL NOT HAVE BEEN OVERGROWN IN THE CONTAINERS SO AS TO HAVE BECOME ROOT BOUND.
- PERFORM INSPECTIONS OF CONSTRUCTION FOR THE FOLLOWING PARTS OF THE WORK
  - INSPECTION UPON COMPLETION OF PRELIMINARY FINISH GRADING AND IRRIGATION SPRINKLER SYSTEM.
  - 4. INITIAL INSPECTION UPON COMPLETION OF PLANTING AND TREE STAYING, PRIOR TO COMMENCEMENT OF MAINTENANCE PERIOD.
- FINAL INSPECTION AT CONCLUSION OF ADDITIONAL 6D DAY LANDSCAPE MAINTENANCE PERIOD.
- LISTEO INSPECTIONS WILL BE MADE BY LANDSCAPE ARCHITECT OR AN AUTHORIZED REPRESENTATIVE.
- REQUEST INSPECTION BY LANDSCAPE ARCHITECT AT LEAST 48 HOURS IN ADVANCE OF TIME INSPECTION IS REQUIRED.
- A. PREPARATION

  - A. IN THE EVENT OF SUCH COMPACTION, CONTRACTOR WILL BE REQUIRED TO RECULTIVATE COMPACTED AREAS. SODDING: RAKE AREAS TO FINISH GRADE ELEVATION TO 1 INCH LOWER THAN ADJACENT PAYING TO ACCOMMODATE SOD THICKNESS.
  - SPREAD 20 POUNDS PER 1,000 SQUARE FEET OF FERTILIZER 'B' ON SOIL SURFACES PRIOR TO SODOING. THEN MEATLY INSTALL SOIL SLABS.
  - C. LIGHTLY WATER AND ROLL ENTIRE AREAS. THEN HEAVILY WATER TO ASSURE WATE PENETRATION OF AT LEAST A DEPTH OF 8 INCHES.
  - SEEDING: APPLY FERTILIZER 'B' TO FINISH GRADED SURFACES AT THE RATE OF 4
    POUNDS PER 1,000 SQUARE FEET. . A. LUSE, ONLY, SEED, THAT, IS, WEED, FREE, FRESH, RECLEANED, GRADE, A., NEW, CROS-CONSISTING OF THE PERCENTAGE OF MIX AS DESCRIBED IN ORAMINGS.
- . C. SOW SEED IN 2 DIRECTIONS AT A TOTAL COMBINED RATE OF 10 POUNDS PER 1,000 SQUARE FEET.
- . D. . SOW SEED. BY EXPERIENCED. PERSONNEL AT A. TIME. WHEN LITTLE. OR NO. WIND.
- F. DO NOT MOW UNTIL TURF IS 2-1/2 INCHES HIGH, AND FOR INTIAL MOWING DO NOT NOW LOWER THAN 1-1/2 INCHES: REMOVE ALL CUPPINGS:
- FERTILIZING DURING WUNTENANCE: APPLY FERTILIZER 'D', 30 CALENDAR DAYS AFTER PLANTING, AT THE RATE OF 5 POUNDS PER 1,000 SQUARE FEET.
- F. WEED CONTROL, PEST CONTROL, & MULCHING
- WEED CONTROL NATERIAL SHALL BE A PRE-EMERGENT HERBICIDE, TRIFLUROUM (TREFLAM) OR DIPHENAMID (DYMID OR EMIDE) OR APPROVED EQUAL, APPLIED ON PLANTED AREAS, DON'T APPLY TO TURE DEVELOPED AREAS.
- CONSIDER IT PART OF CONTRACTOR'S WORK TO CONTROL ON-SITE OR NEARBY PESTS THAT ARE DISTURBING THE CONDITION OF LANDSCAPE IMPROVEMENTS. CONTROL OF PESTS INCLUDES, BUT IS NOT LIMITED TO RODENTS, RABBITS, INSECTS, DEER, ETC.
- REPAIR DAMAGE THAT OCCURS TO THE ORIGINAL CONDITION OF IMPROVEMENTS, INCLUDING REPLACEMENT OF PLANT MATERIAL WHEN REQUIRED, WITHOUT ADDITIONAL COST TO DWINER. SPREAD BARK CHIP MULCH EVENLY OVER ENTIRE PLANTED AREA, EXCEPT TURF DEVELOPED AREAS, TO A MINIMUM DEPTH OF 2".

G. PRELIMINARY INSPECTION AND STAGE ACCEPTANCE


- UPON COMPLETION OF PLANTING WORK, NOTIFY LANDSCAPE ARCHITECT THAT PROJECT IS READY FOR INSPECTION. UPON INSPECTION, IF LANDSCAPE ARCHITECT FINDS ENTIRE PROJECT COMPLETE AND IN COMPLIANCE WITH DRAWINGS AND SPECIFICATIONS, STAGE ACCEPTANCE WILL BE CRAINTIE.
- 3. IF ASPECTS OF PROJECT ARE INCOMPLETE OR IMPROPERLY INSTALLED, CONTRACTOR WILL BE NOTIFIED AND HAVE 5 WORKING DAYS IN WHICH TO CORRECT OR COMPLETE THE WARM
- 4. STAGE ACCEPTANCE WILL BE GIVEN ONLY WHEN ALL WORK IS CORRECT AND COMPLETE THE STAGE ACCEPTANCE BY LANDSCAPE ARCHITECT OF LANDSCAPE PROJECT WILL ESTABLISH THE BEGINNING OF PLANT MAINTENANCE PERIOD.
- UPON COMPLETION OF WORK, REMOVE EXCESS MATERIALS, RUBBISH, DEBRIS, AND SUB-CONTRACTOR'S CONSTRUCTION AND INSTALLATION EQUIPMENT FROM THE PREMISES. Final inspection of the work will be made by landscape architect in the presence of the sub-contractor when work is completed. Notification shall be made by the contractor 48 hours in advance of such inspection.



477 SOUTH TAAFFE STREET SUNNYVALE, CALIFORNIA 94086 webt www.rathuret / email: paul@rathuret

ODYSSEY **PRESCHOOL** 


430 S, ABEL ST, MILPITAS, CA 95035

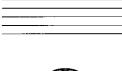

Drawn JH Project No. 14.27

LANDSCAPE **SPECIFICATION** PLAN

L4.0

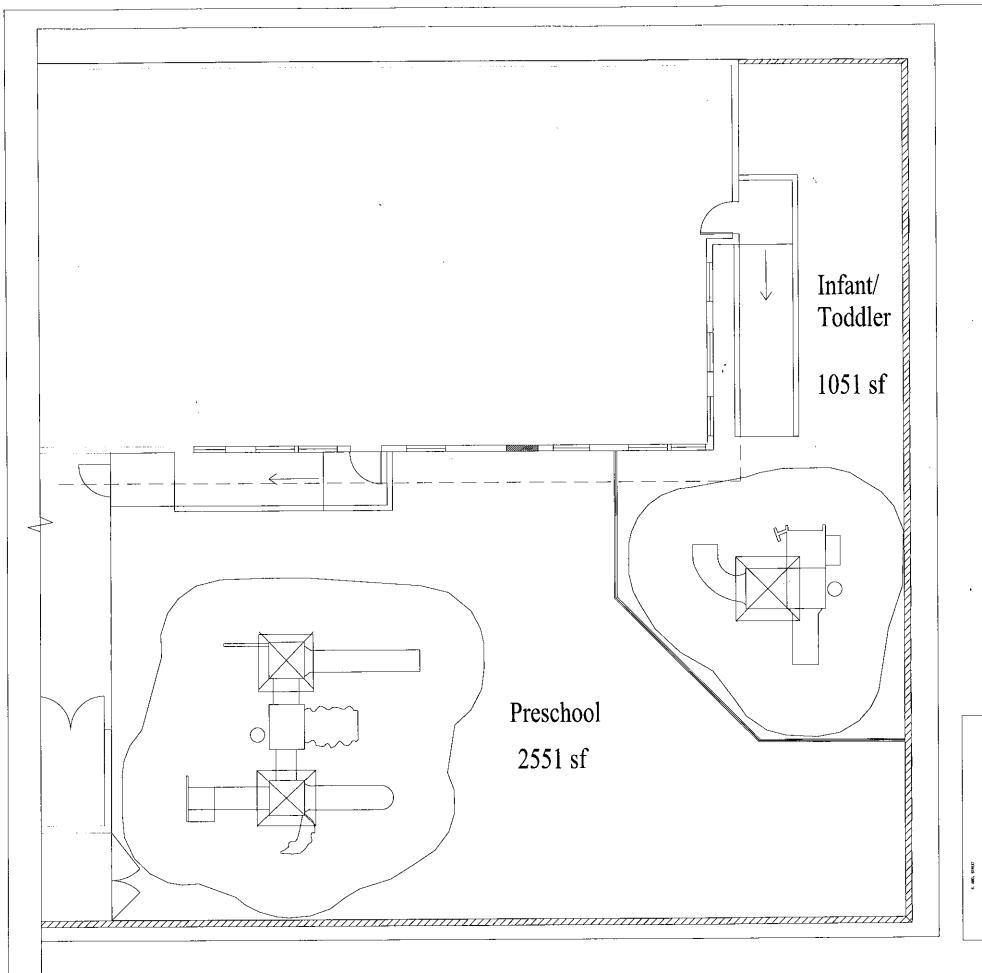



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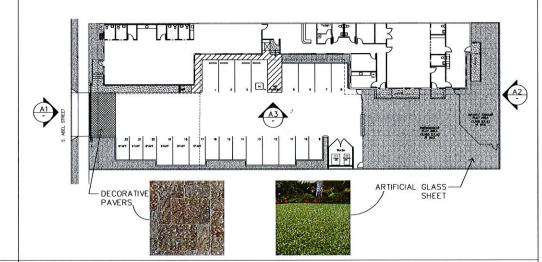
	Lafonce Tourister 1855 st
KEY PLAN	

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SHEET	TITLE:

SCALE: 1/4"=1'-0"



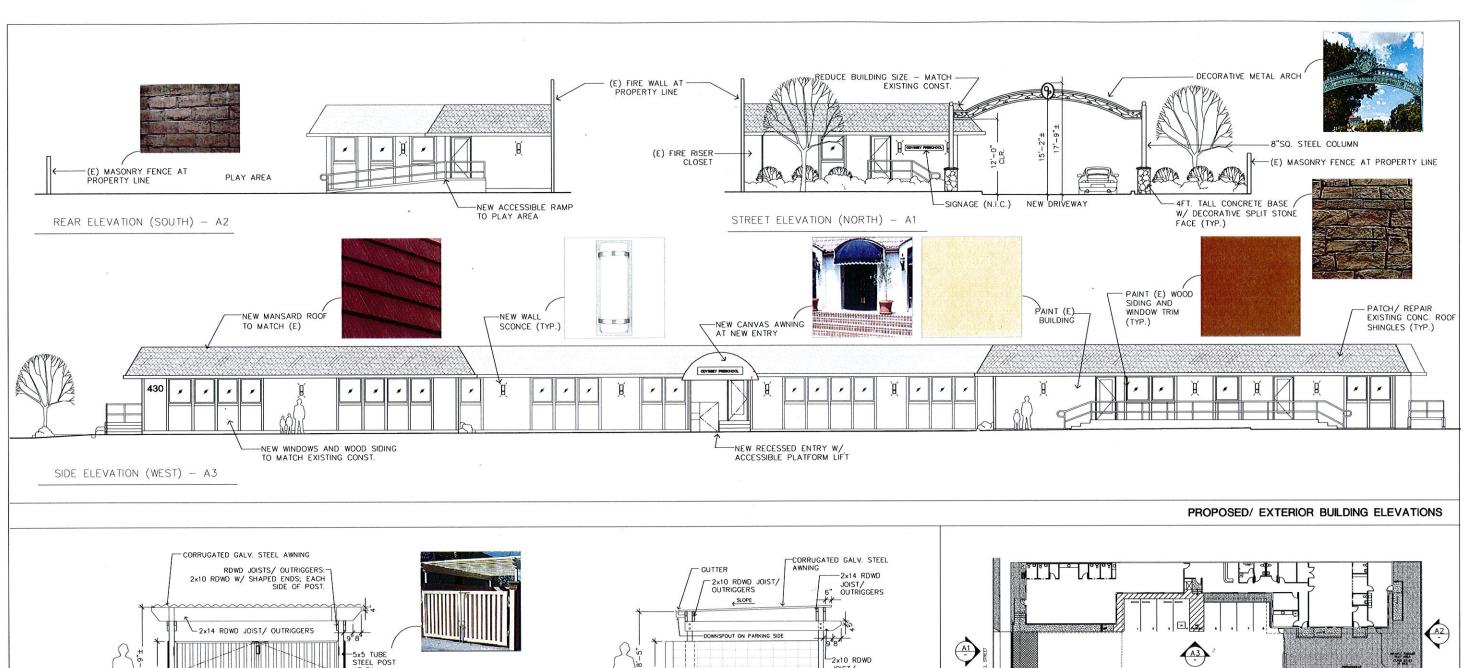

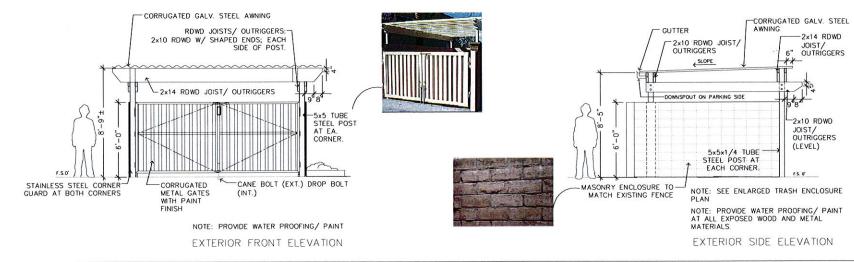

## PROPOSED TRASH ENCLOSURE ELEVATIONS

# KEY PLAN

## - PRODUCT SPECIFICATIONS -

EXISTING ROOF SHINGLES
MATCH (E) CONCRETE TILES

EXTERIOR PAINT COLOR
BUILDING - KELLY-MOORE, EXTERIOR
ACRY-SHIELD #1245 (LOW SHEEN),
KM5229-2 BLENDED FRUIT.

TRIM — KELLY-MORE, EXTERIOR ACRY-SHIELD #1250 (SEMI-GROSS), KM5709-5 MILL CREEK MASONRY FENCE MATCH EXISTING.

DOMED ENTRANCE CANOPY SUNBRELLA, COLOR: (BLUE)

WALL SCONCE
MINKA LAVERY, 341-84 BRUSHED
NICKEL 2 LIGHT WALL SCONCE.
SIZE: 6.75"Wx17.25"H

VENEER STONE TILE (ARCH)
TEXTURE PLUS, STONEWALL,
STANDARD.
SIZE: 2'T x 4'W x 5/8 TO 3/4" THK.
COLOR: (T.B.D.)

CUSTOM METAL ARCH
APPLY MODERN MASTERS METAL
EFFECTS OVER METAL WROUGHT

CORRUGATED METAL GATE (TRASH)
AEP SPAN, REVERSE BOX RIB W/
STL. FRAME (PAINTED),

MASONRY TRASH ENCLOSURE MATCH EXISTING FENCE.

STONE PAVERS
BELGARD, BERGERAC, COLOR:
VICTORIAN

ARTIFICIAL LAWN
SYNLAWN PLAYGROUND PLATINUM,

# FINISH BOARD

ODYSSEY PRESCHOOL 430 S. ABEL STREET MILPITAS, CA 95035

kma architecture-deelgn